

Dist	COUNTY	ROUTE	POST MILES TOTAL PROJECT	SHEET No.	TOTAL SHEETS
03	Pla	65	R11.9/R24.1		
REGISTERED CIVIL ENGINEER					DATE
PLANS APPROVAL DATE					
<small>THE STATE OF CALIFORNIA OR ITS OFFICERS OR AGENTS SHALL NOT BE RESPONSIBLE FOR THE ACCURACY OR COMPLETENESS OF SCANNED COPIES OF THIS PLAN SHEET.</small>					



UTILITY PLAN SHEET, EXAMPLE "65 U-1" RELEASED 03/19/2018

NOTES:


- FOR ACCURATE RIGHT OF WAY DATA, CONTACT RIGHT OF WAY ENGINEERING AT THE DISTRICT OFFICE.
- ELEVATIONS SHOWN REFER TO THE TOP OF PIPE OR CONDUIT, UNLESS OTHERWISE STATED.
- UTILITY OWNERSHIP:
 GAS - PACIFIC GAS & ELECTRIC (PG&E)
 ELECTRICAL - PACIFIC GAS & ELECTRIC (PG&E)
 WATER - CITY OF LINCOLN
 SEWER - CITY OF LINCOLN
 STORM DRAIN - CITY OF LINCOLN
 IRRIGATION CANAL - SOUTH SUTTER WATER DISTRICT
 IRRIGATION LINE - CITY OF LINCOLN
 OIL - KINDER MORGAN
 TELEPHONE - AMERICAN TELEPHONE & TELEGRAPH (AT&T)
 FIBER OPTIC - SUREWEST
 FIBER OPTIC - AMERICAN TELEPHONE & TELEGRAPH (AT&T)
 FIBER OPTIC - QWEST
 COMMUNICATION LINE - UNION PACIFIC RAILROAD
- AT&T/SUREWEST FIBER OPTIC LINES TO BE LOWERED TO MINIMUM 42" BELOW GRADING PLANE BETWEEN STATIONS "IND1" 53+05 TO "IND1" 55+12 BY OTHERS

ABBREVIATIONS:

SSFM SANITARY SEWER FORCE MAIN

First sheet of utility plans should contain notes, legends, symbols, and a list of abbreviations (do not include standard plan symbols, abbreviations or acronyms). Utility owners must be identified by labeling each utility line. Full name of owner and associated acronym identifying each owner may be shown in notes (owner acronym can then be used to label the remaining utility sheets).

When a "Joint Trench" or "Joint Overhead" facility is shown on the plans, the specific utilities are to be identified on the individual plan sheets.
See Example "65 U-7"

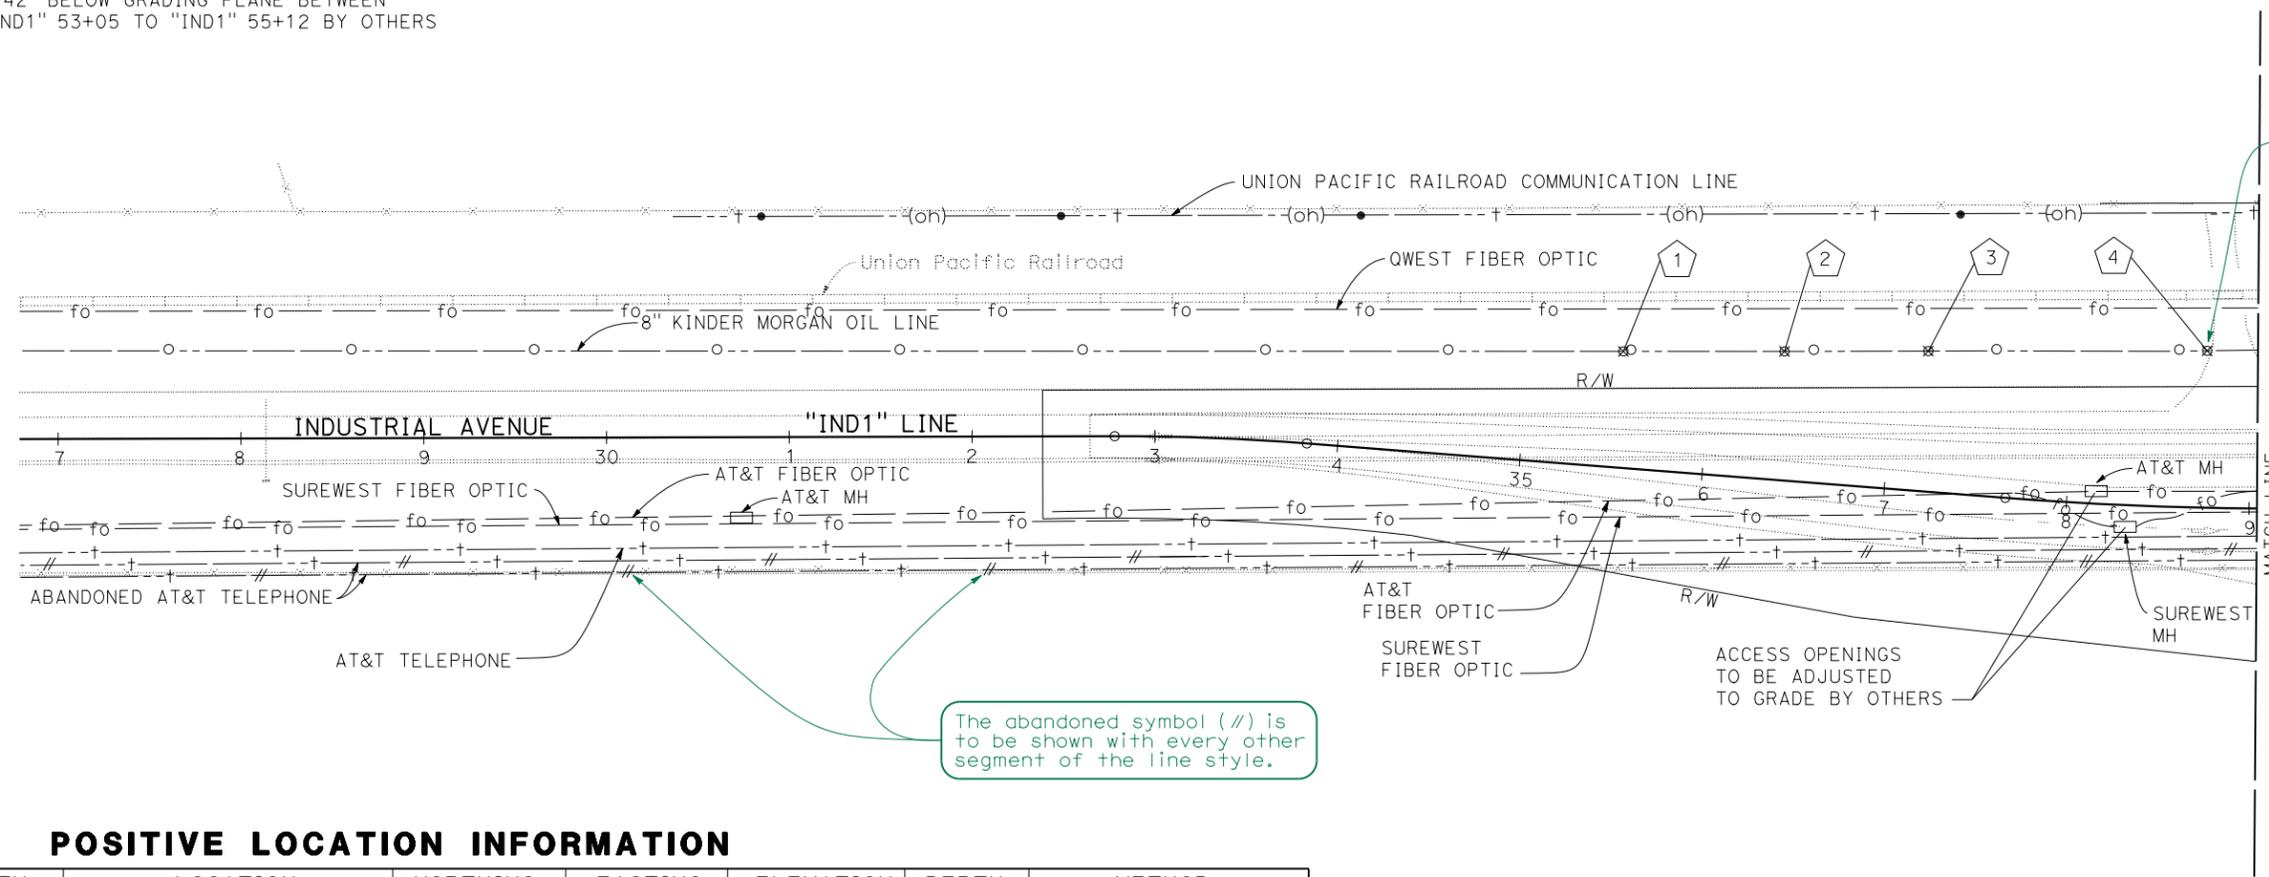

New symbol for exact location.

The abandoned symbol (//) is to be shown with every other segment of the line style.

POSITIVE LOCATION INFORMATION

No.	UTILITY	LOCATION	NORTHING	EASTING	ELEVATION	DEPTH	METHOD
1	OIL	63.5' L+ "IND1" 35+51.9	2061357.1	6761823.0	135.0	4.3	TEST HOLE
2	OIL	70.3' L+ "IND1" 36+39.8	2061442.1	6761850.2	135.3	4.3	ELECTRONIC DETECTION
3	OIL	76.6' L+ "IND1" 37+18.2	2061518.3	6761875.9	135.8	4.2	ELECTRONIC DETECTION
4	OIL	85.7' L+ "IND1" 38+75.2	2061654.4	6762112.4	135.7	4.1	ELECTRONIC DETECTION

THIS EXAMPLE IS ONE OF MANY EXAMPLES OF THE VARIOUS TYPES OF PROJECT PLAN SHEETS FROM THE SAME CONSTRUCTION PROJECT, "ROUTE 65 BYPASS PROJECT."

UTILITY PLAN SHEET, EXAMPLE "65 U-1"

TO BE USED FOR UTILITY INFORMATION ONLY

UTILITY PLAN
SCALE: 1" = 50'

U-1

STATE OF CALIFORNIA - DEPARTMENT OF TRANSPORTATION
Caltrans

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